



1 OF 3

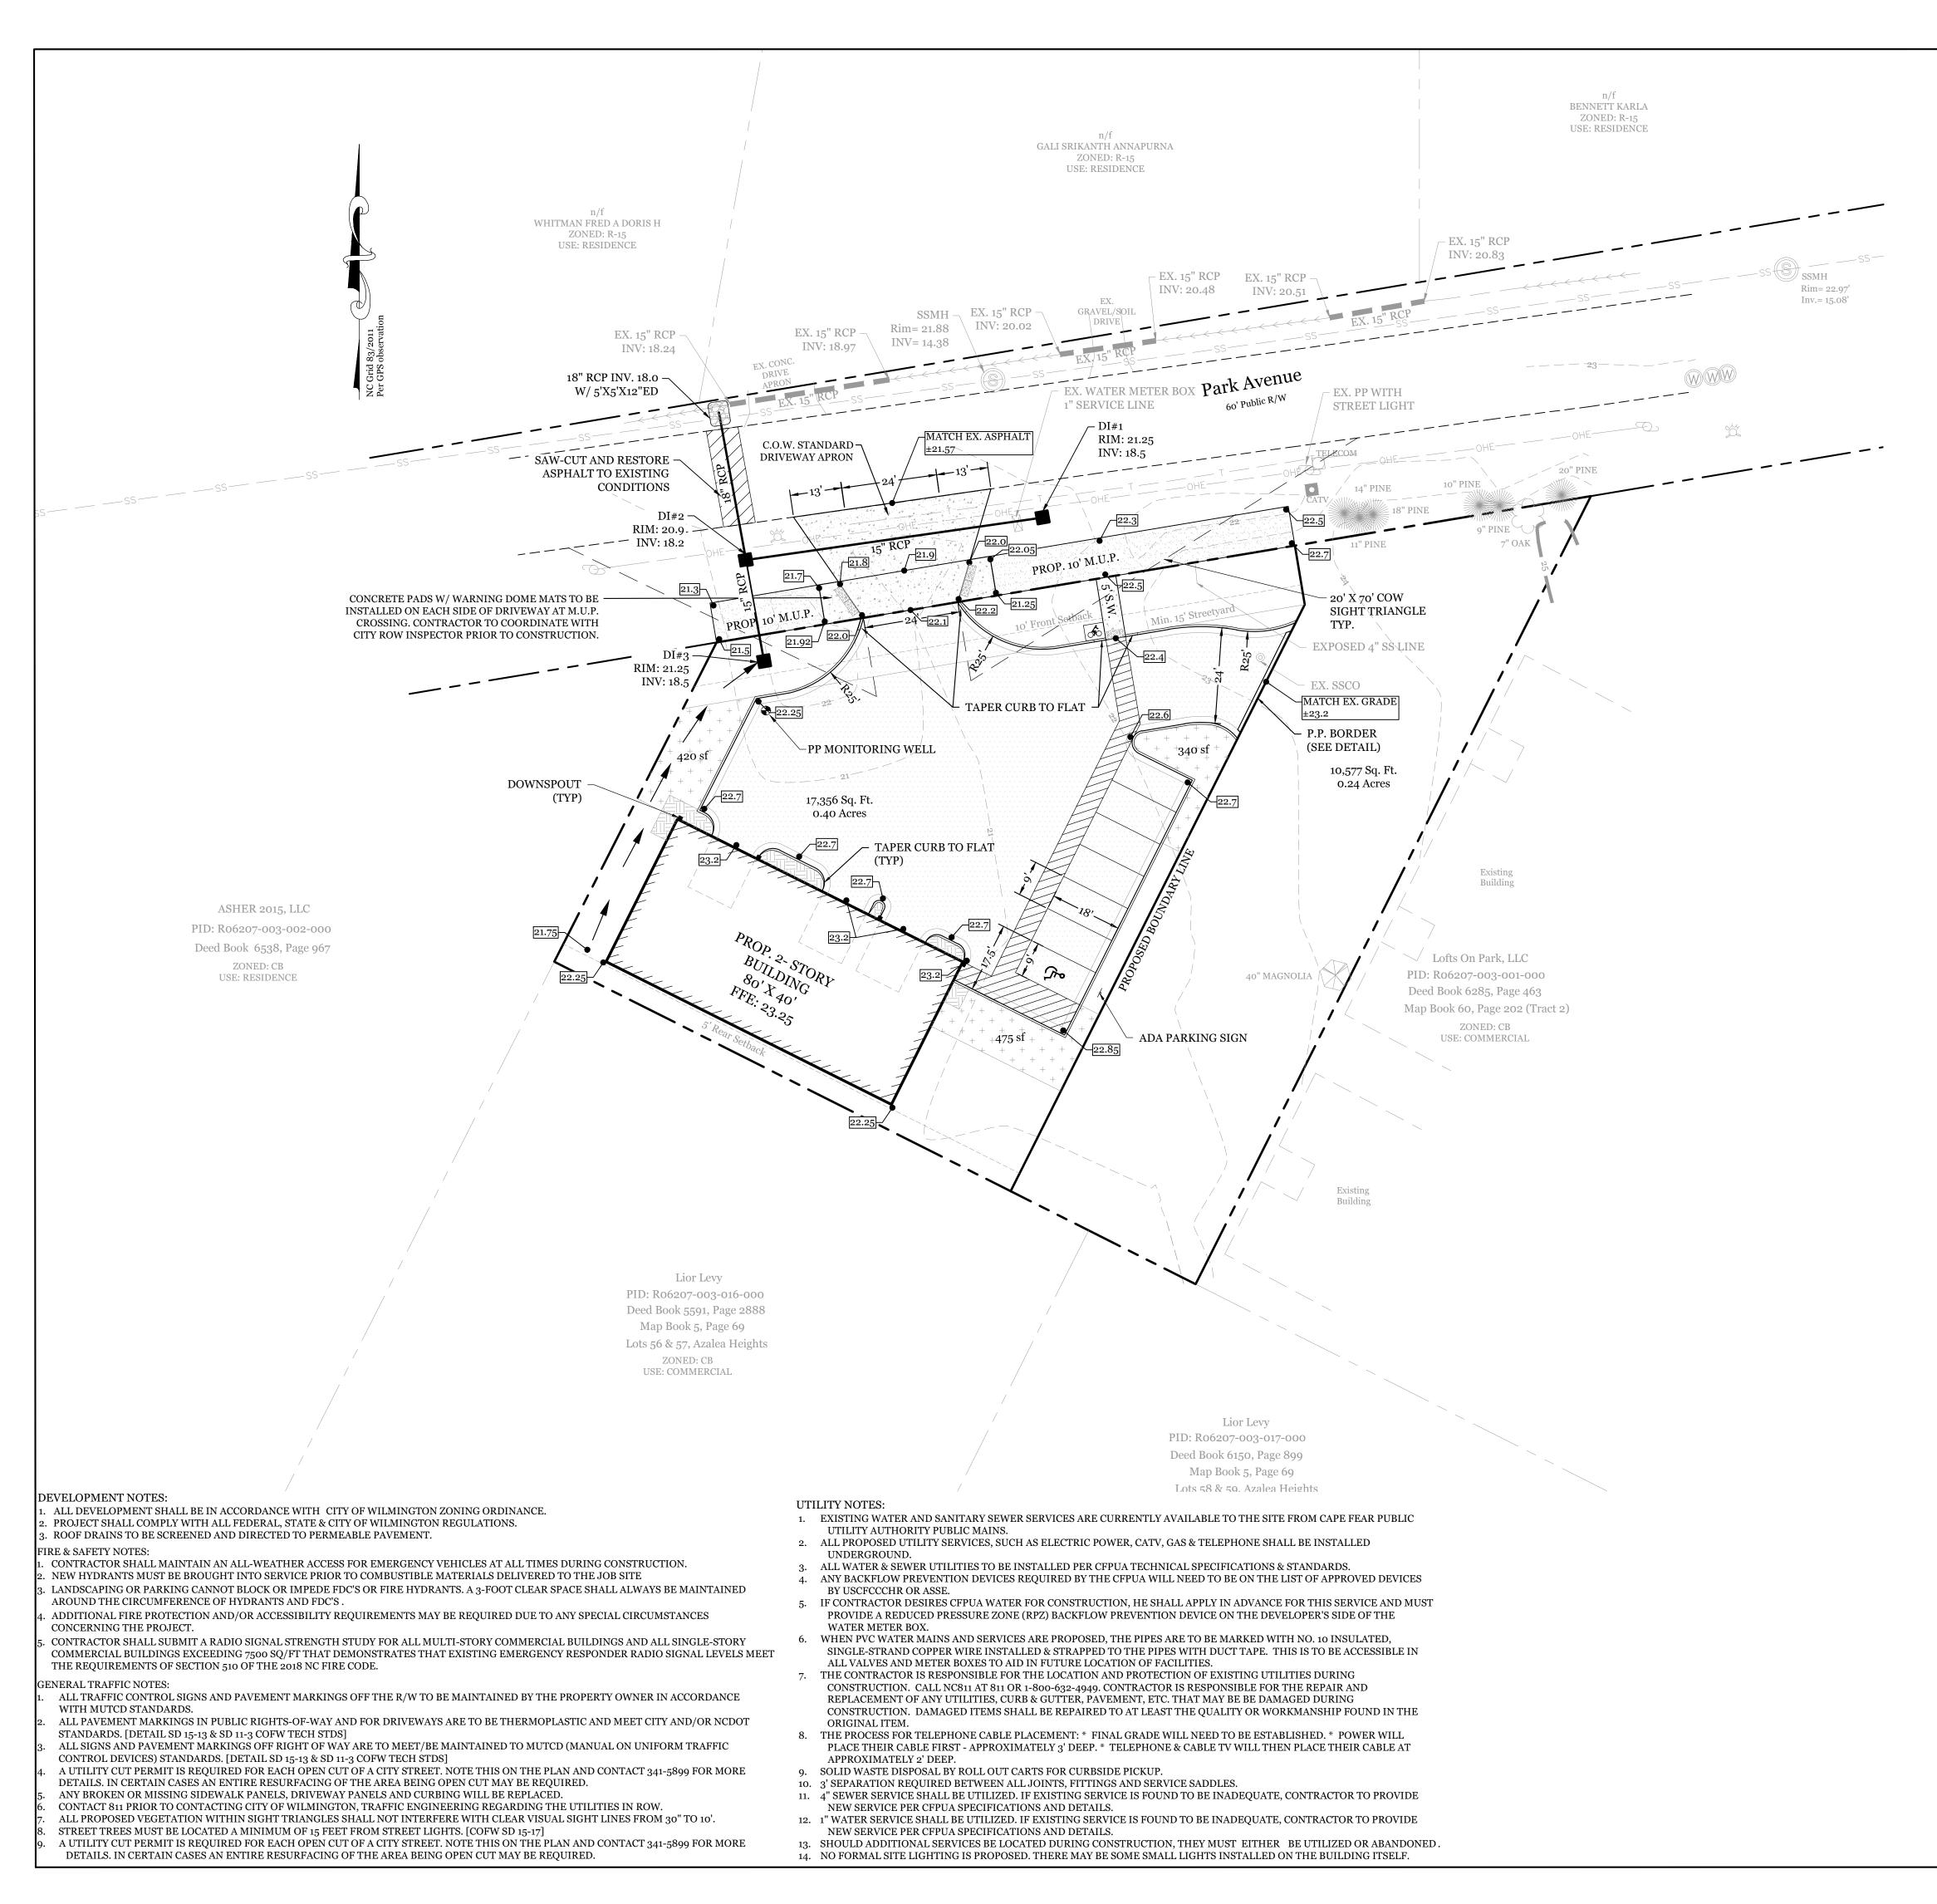

					MAP (N	OT TO SCAL	E).
SITE DATA					/	01 10 0011	
PARCEL ID:		R06207-003-03	19-000				Ę
ZONING:		CB-COMMUNI	TY BUSINESS		/		
CAMA LAND USE CLA	ASSIFICATION:	WATERSHED	RESOURCE PROTECTION	Ave	Park Ave	Τ	
PROJECT ADDRESS		5740 PARK AV WILMINGTON		Hinton	Marguerite		
CURRENT OWNERS:		STEPHEN & HO 6252 TOWLES WILMINGTON			/	581	
TOTAL ACREAGE IN	PROJECT BOUNDARY	17,356 S.F. (±0.	40 AC.)		/		
PROPOSED USE:		GENERAL BUS	SINESS SERVICES		REVIS	IONS	
PROPOSED CONSTRU	JCTION TYPE:	II-B (COMMER	CIAL)				
BUILDING SIZE:		4,700 GFA					
BUILDING HEIGHT:		±24' / 2 STORY	' (45' MAX PER ZONING)				
BUILDING SETBACKS	5:	• /					
FRONT: SIDE: REAR:	REQUIRED= 10' REQUIRED= 0'/25 TO RES. REQUIRED= 5'/25' TO RES.	PROPOSED= 1 PROPOSED= 3 PROPOSED= 6	6.5'L / 11'R				
CALCULATION FOR F PROPOSED CO	BUILDING COVERAGE : VERAGE	3,200 S.F. ÷ 17,	356 S.F. = 18.4% (30% MAX)		\bigcirc	m	
BUILDING CONCRETE SIE TOTAL: *Site required to meet MAXIMUM site PROPOSED ON-SITE PERMEABLE CO PROPOSED OFF-SITE CONCRETE DR ASPHALT M.U. TOTAL: PARKING REQUIREM 1 per 300 square feet o BASELINE (MA MIN. REQUIREM **40% of Max required PARKING PROVIDED BICYCLE PARKING R REQUIRED: PROVIDED: FOUNDATION PLANT REQUIRED: PROVIDED:	DEWALK, C&G, ETC. Exceptional Design Criteria for impervious area of 50%* PERVIOUS AREAS: DNCRETE PARKING IMPERVIOUS AREAS: IVEWAY APRON P. IENTS (4,700 S.F. GENERAL I f GFA, plus 1 for each service von X): D**: I due to being within 650' of a r = EQUIRED: (2 spaces or 1 per 5 2 5 FINGS:	7,922 S.F. ,007 S.F. ,183 S.F. 2,190 S.F. BUSINESS SERVIO 2 SPACES (1 AI 27 SPACES (1 AI 27 SPACES (1 AI 27 SPACES (1 AI 2000 square feet of 2 SPACES 23 SPACES 292 SF (80 L.F. X 2 205 SF	ces in excess of 25.0% up to a CES): ^{AA)}	INTRACOASTAL	RING,	5725 Oleander Dr. Unit E-7Wilmington, North Carolina 28403Phone: 910.859.8983Email: Charlie@intracoastalengineering.comLicense Number P-0662	
_	IN 40' MAX. (147 LF - 25 LF						
ESTIMATED TRIP GE 3,200 SF WAREHOUS	NERATION: (Per Trip Generat E (ITE CODE 150) AM PEAK: 1	tion Manual): PM PEAK: 1	DAILY: 10	Щ. Щ.			NA
1,500 SF OFFICE (ITE		PM PEAK: 1	DAILY: 17	AG			OLI
PROJECT TOTAL:	AM PEAK: 3	PM PEAK: 2	DAILY: 27	NG, DRAIN	FOR	'AY PARK	NORTH CAR


		 -	EASEMENT
w		w	CENTER LINE EXISTING WATERLINE
ss	— —ss— —	ss	Ss EXISTING SANITARY SEWER LIN RUNOFF FLOW DIRECTION
			25.5 SPOT ELEVATION
		-	FOUNDATION PLANTINGS
			BIKE RACK
			PERMEABLE CONCRETE PARKIN
20'	10'	0'	20' 40'

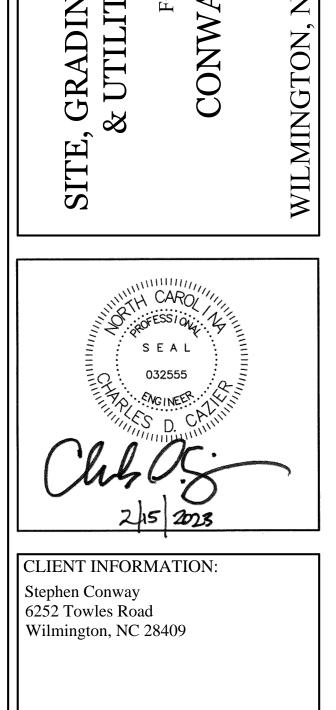


DRAWN:	JAE	SHEET SIZE:	24 X 36
CHECKED:	CDC	DATE:	2/15/2023
APPROVED:	CDC	SCALE:	1" = 20'
PROJECT NUMBE	ER:	2022-012	

C-1

DRAWING NUMBER:

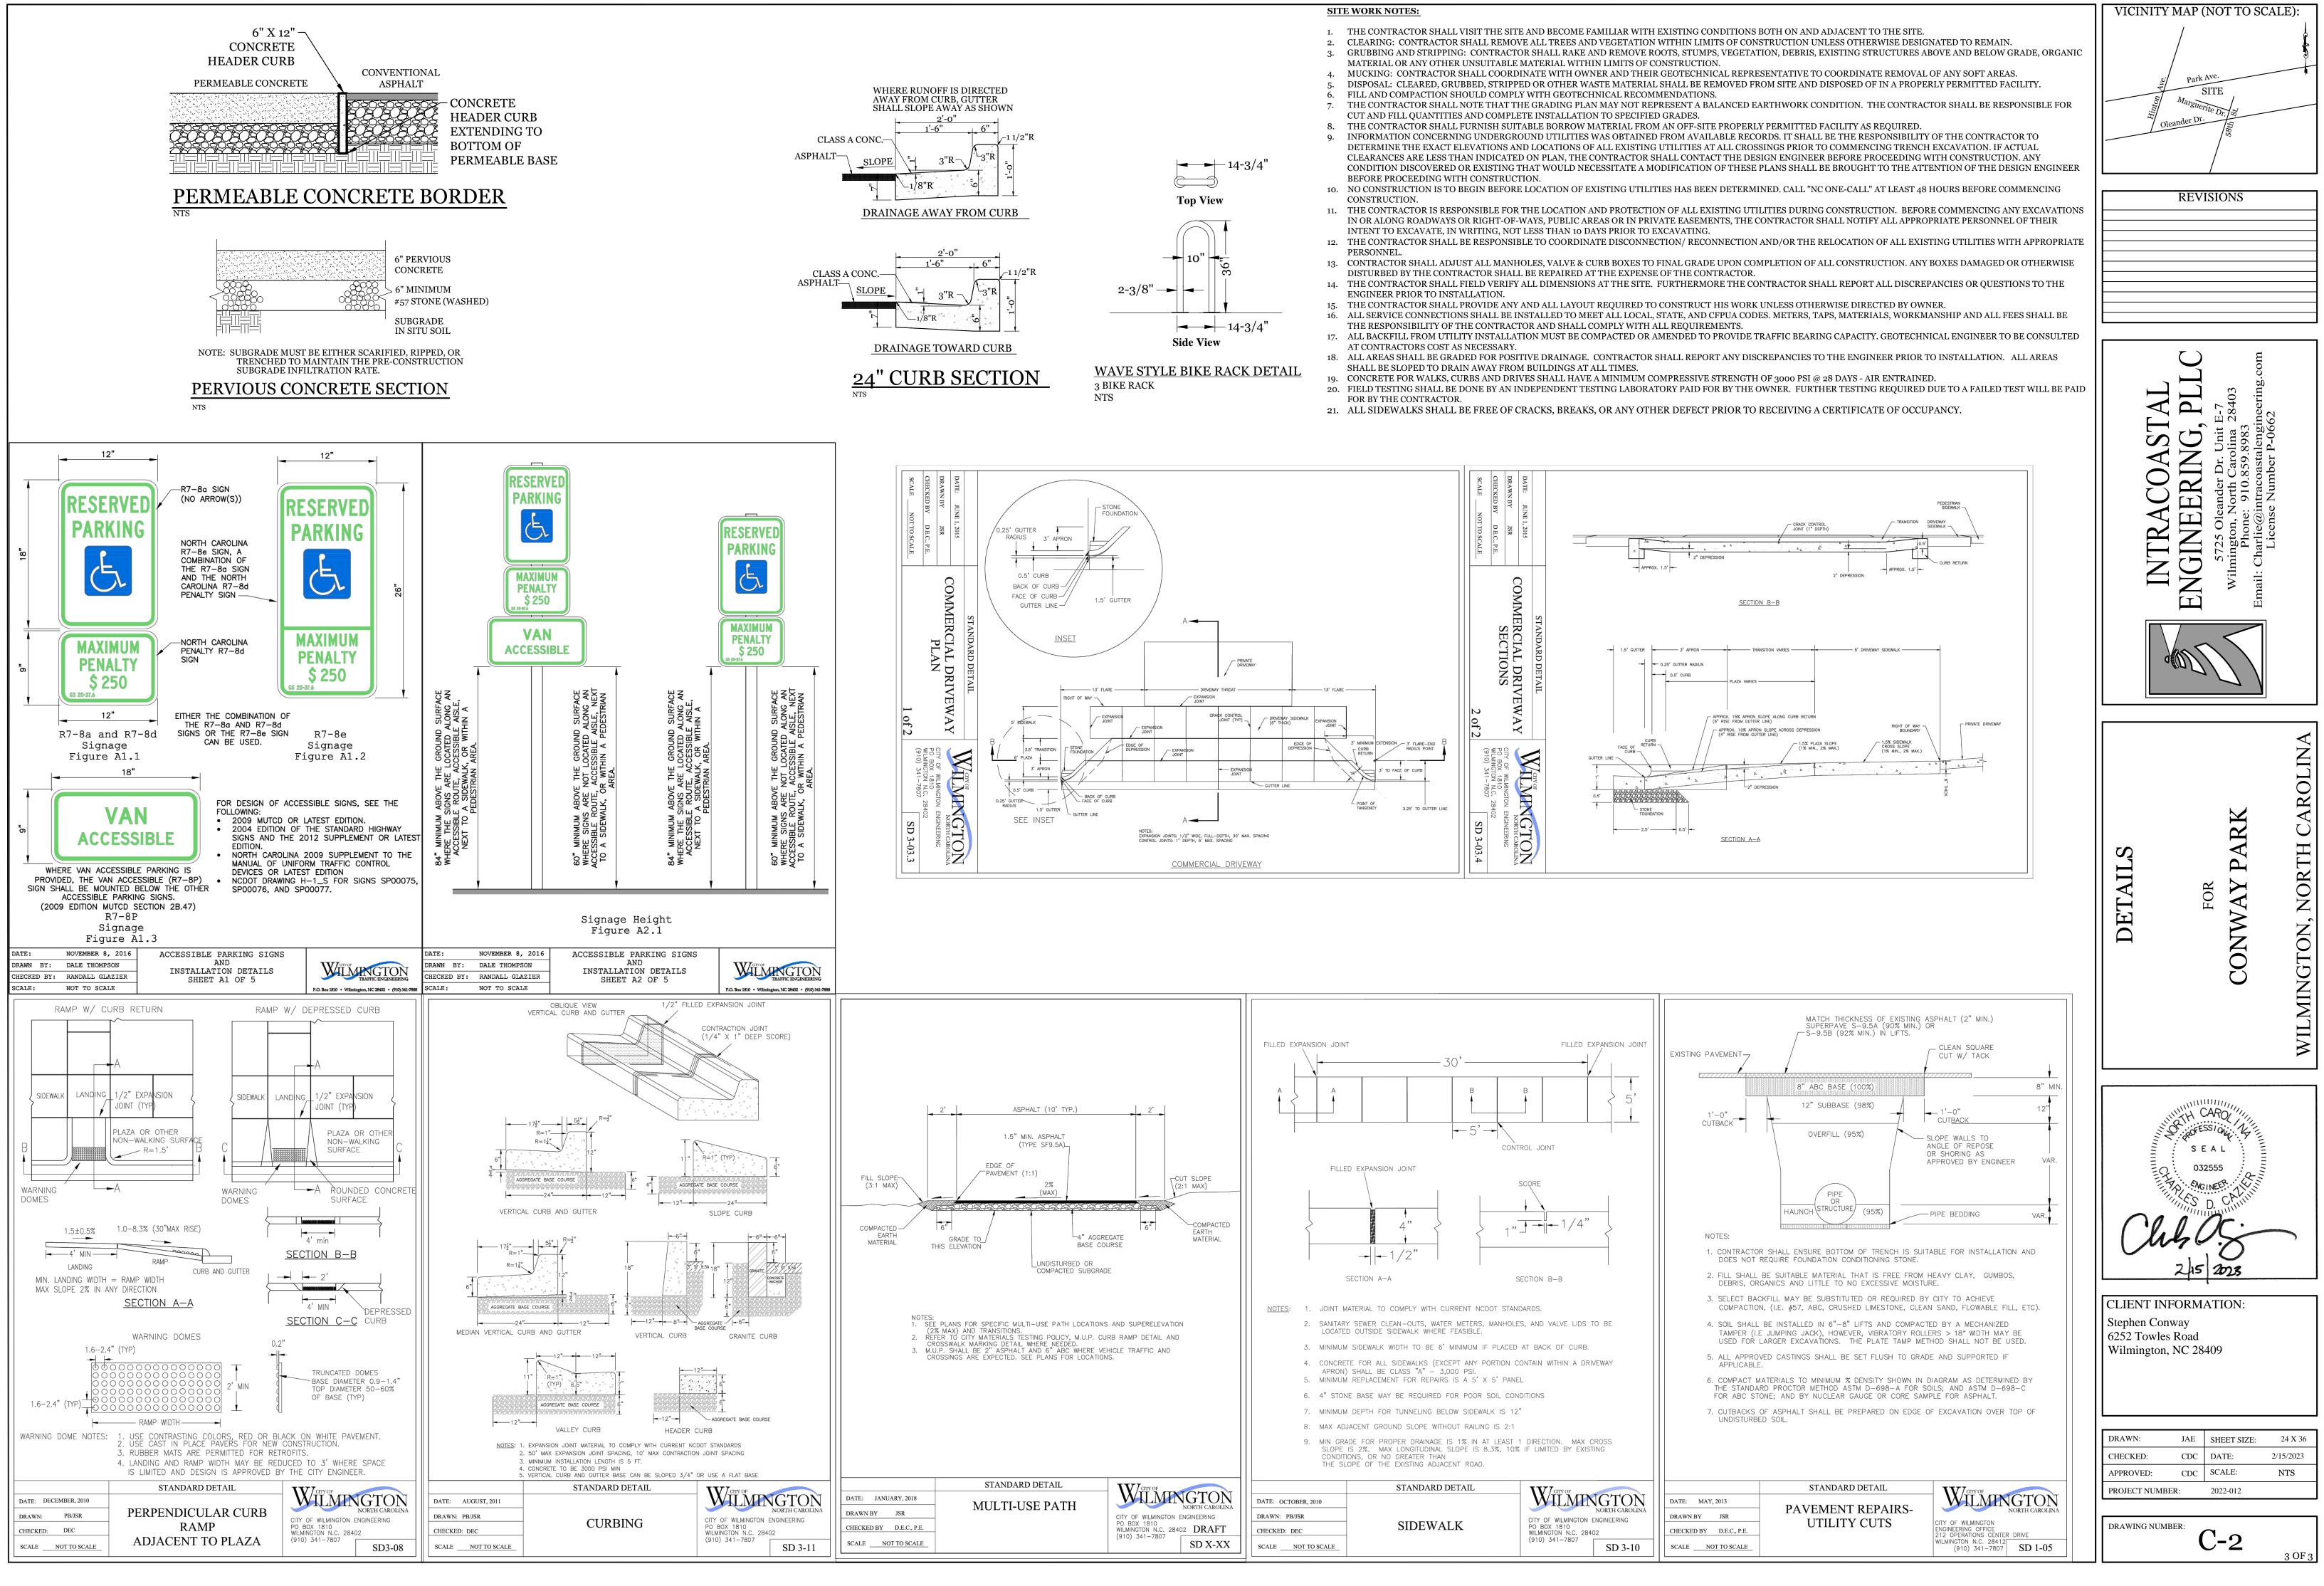

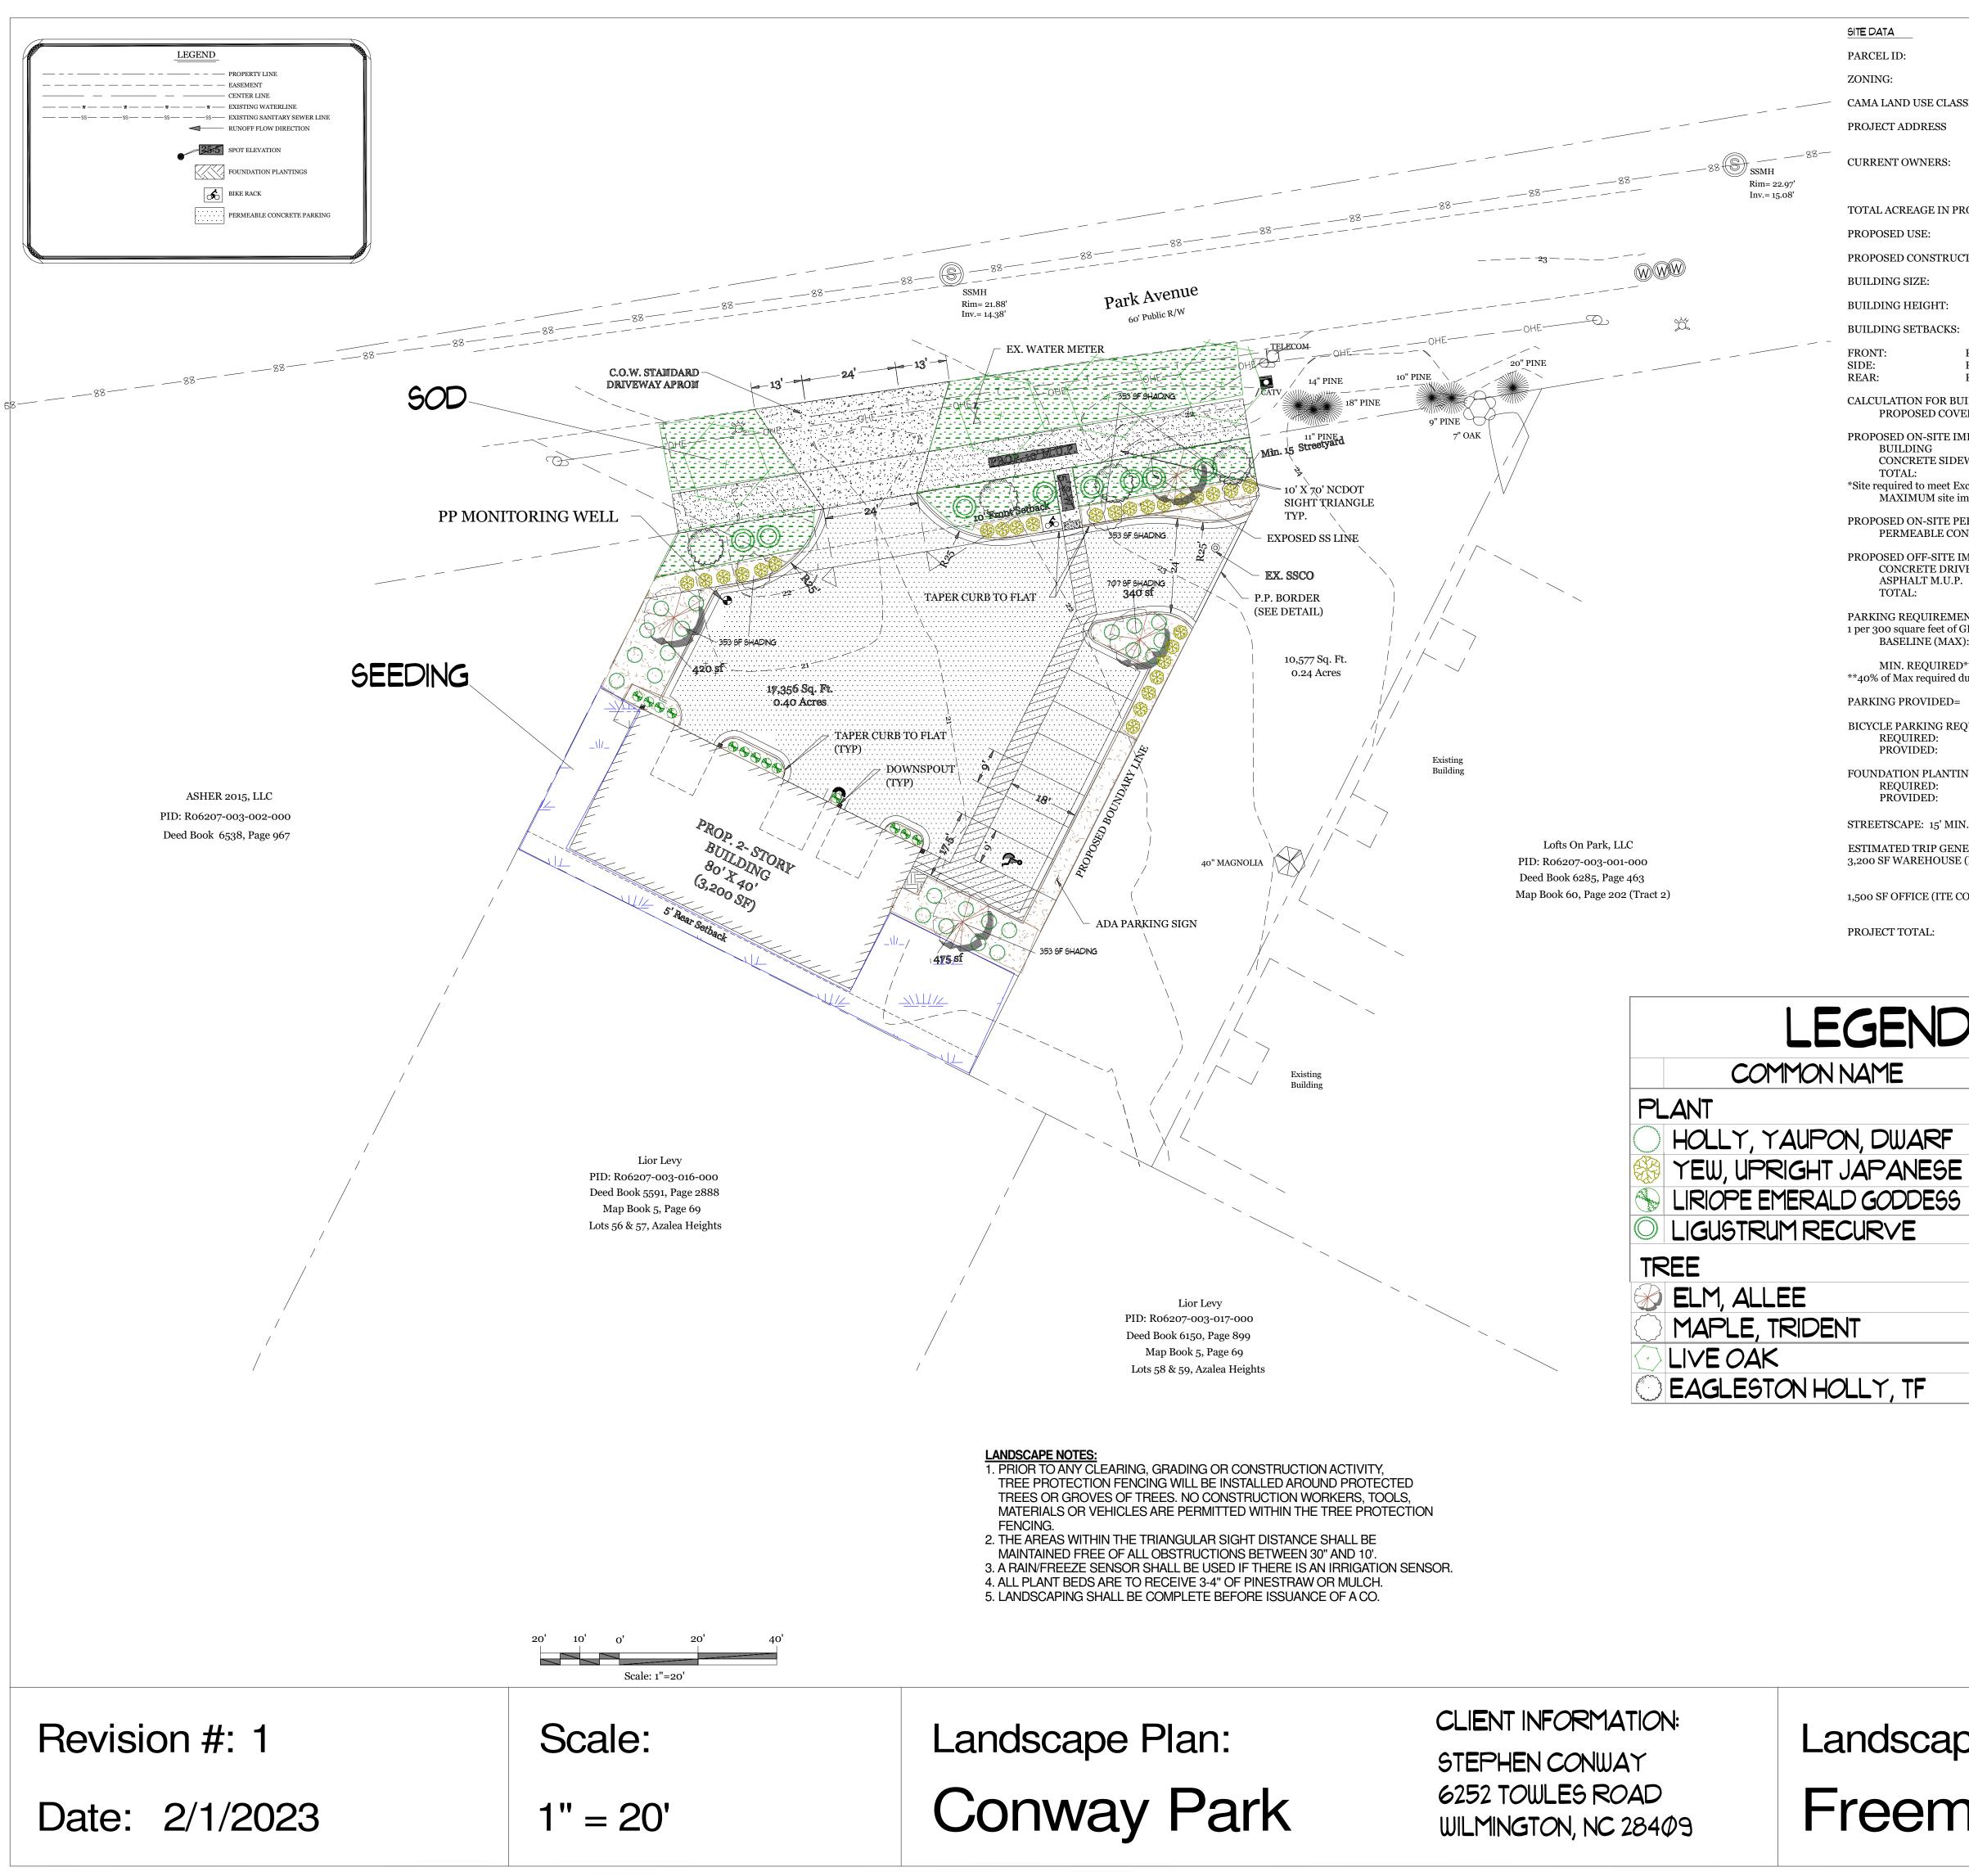

					VICINITY MAP (NOT TO SCALE):
	R06207-003-019-0	00			
	CB-COMMUNITY I	BUSINESS			
SSIFICATION:	WATERSHED RES	OURCE PROTECTION			$\begin{array}{c c} & & & \\ & & & \\ & & & \\ \hline \\ \hline$
	5740 PARK AVE. WILMINGTON, NO	C 28403			Cleander Dr.
	STEPHEN & HOPE 6252 TOWLES RD WILMINGTON, NC 284	CONWAY			
ROJECT BOUNDARY	17,356 S.F. (±0.40	AC.) × 15 = 6 TREES 2"	CAL. REQ'D & PROV'D.		
	GENERAL BUSINE	CSS SERVICES			
CTION TYPE:	II-B (COMMERCIA	L)			
	4,700 GFA				
	±24' / 2 STORY (45	' MAX PER ZONING)			
:					
REQUIRED= 10' REQUIRED= 0'/25 TO RES. REQUIRED= 5'/25' TO RES.	PROPOSED= 15' PROPOSED= 36.5'I PROPOSED= 6'	L / 11'R			
UILDING COVERAGE: 'ERAGE	3,200 S.F. → 17,350	6 S.F. = 18.4% (30% M	AX)		
MPERVIOUS AREAS:					
EWALK, C&G, ETC.	3,200 S.F. 845 S.F.				
Exceptional Design Criteria for i impervious area of 50%*	4,045 S.F. (23.3%)* mpervious surfaces in ex	xcess of 25.0% up to a			
PERVIOUS AREAS: DNCRETE PARKING		10 = 792 SF SHADING R	REQ'D.		
IMPERVIOUS AREAS: VEWAY APRON 2.	211 3 SF 5H 4 1,007 S.F. 1,183 S.F. 2,190 S.F.	ADING PROV'D.			
ENTS (4,700 S.F. GENERAL BI GFA, plus 1 for each service veh K):					
D**: due to being within 650' of a re	7 SPACES (1 ADA) sidential district**				
=	7 SPACES (1 ADA)				
QUIRED: (2 spaces or 1 per 5,0	2 SPACES 3 SPACES	whichever is greater)			
INGS:	192 SF (80 L.F. X 20' F 205 SF	ACADE X 12%)			
N 40' MAX. (147 LF - 25 LF =	= 122 LF) 22 LF / ØØ =	1.22; I CANOPY & 4 UND	DERSTORY TREES & 7 SHRUBS	REQ'D. & PROV'[D.
NERATION: (Per Trip Generation E (ITE CODE 150)	on Manual):				
AM PEAK: 1	PM PEAK: 1	DAILY: 10			

AM FEAR, I	FM FEAK, I	DAILI. 10
ODE 710)		
AM PEAK: 2	PM PEAK: 1	DAILY: 17
AM PEAK: 3	PM PEAK: 2	DAILY: 27

	QTY	SIZE	
	22	3 GAL .	
	27	7 GAL.	3' HT. LOW BUFFER
)	13	IGAL.	
	8	3 GAL.	
	4	2" CAL.	CANOPY
	3	2" CAL.	CANOPY
	4	2" CAL.	CANOPY
	4	8' HT.	UNDERSTORY



Landscape Design by: Jim Freeman - NCLC# 0071

Freeman Landscape, Inc.